

GENERAL NOTE:

1. SEE ARCHITECTURAL DRAWINGS FOR ACOUSTIC PANEL LOCATIONS AND LAYOUT.

2. SEE AX501 FOR ACOUSTICAL PANEL MOUNTING DETAIL.

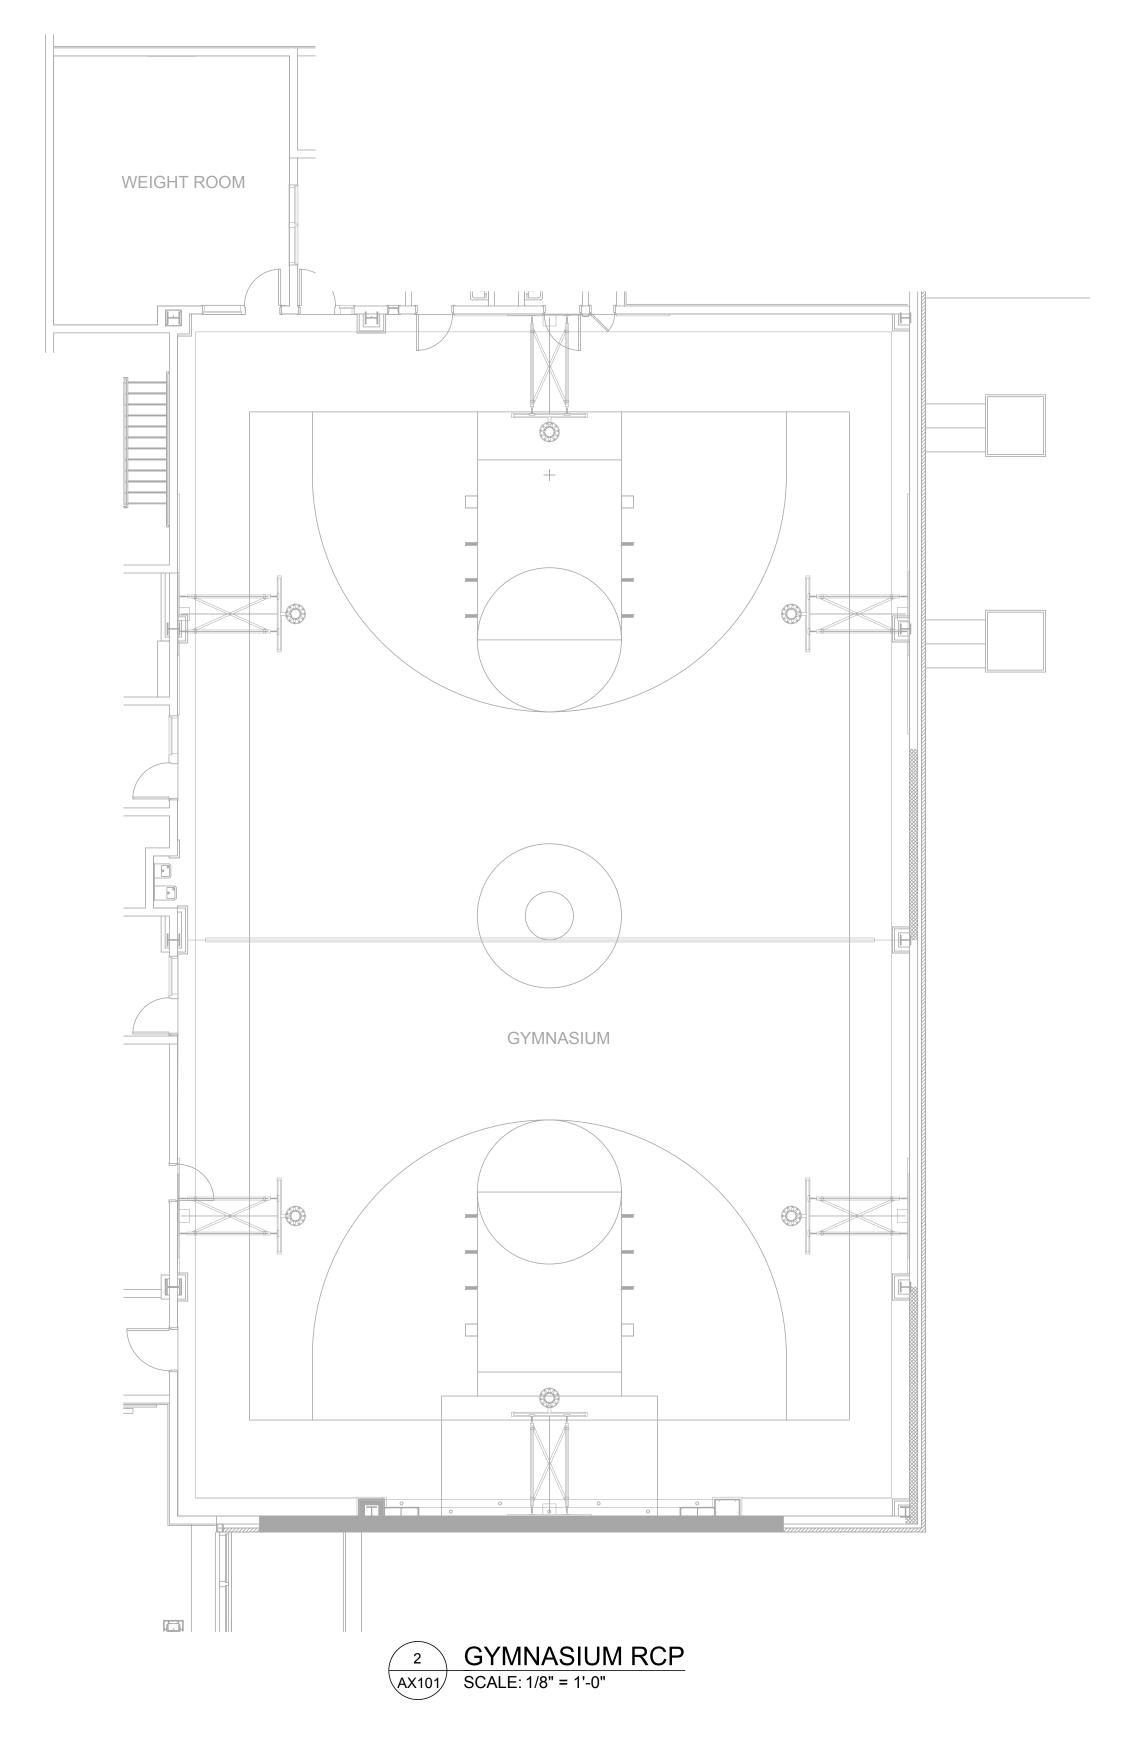

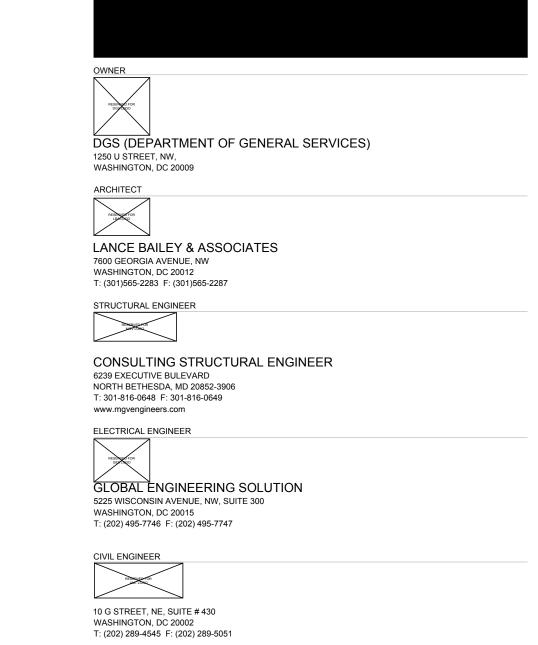

ACOUSTICAL AND TECHNOLOGY CONSULTANT

POLYSONICS
Acastics & Technology Consulting
405 Belle Air Lane
Warmeton, VA 20186
540-341-4988

405 BELLE AIR LANE WARRENTON, VA 20186 T: (540) 341-4988 F: (540) 341-0909

SUBMISSION SCHEDULE DATE
50% DESIGN DEVELOPMENT 07/28/15
CONSTRUCTION DOCUMENTS 08/14/15

REVISION SCHEDULE DATE

NO DESCRIPTION

PROJECT:

DYRS GYMNASIUM **RENOVATION**

1000 MOUNT OLIVET ROAD, NE WASHINGTON, DC 20002


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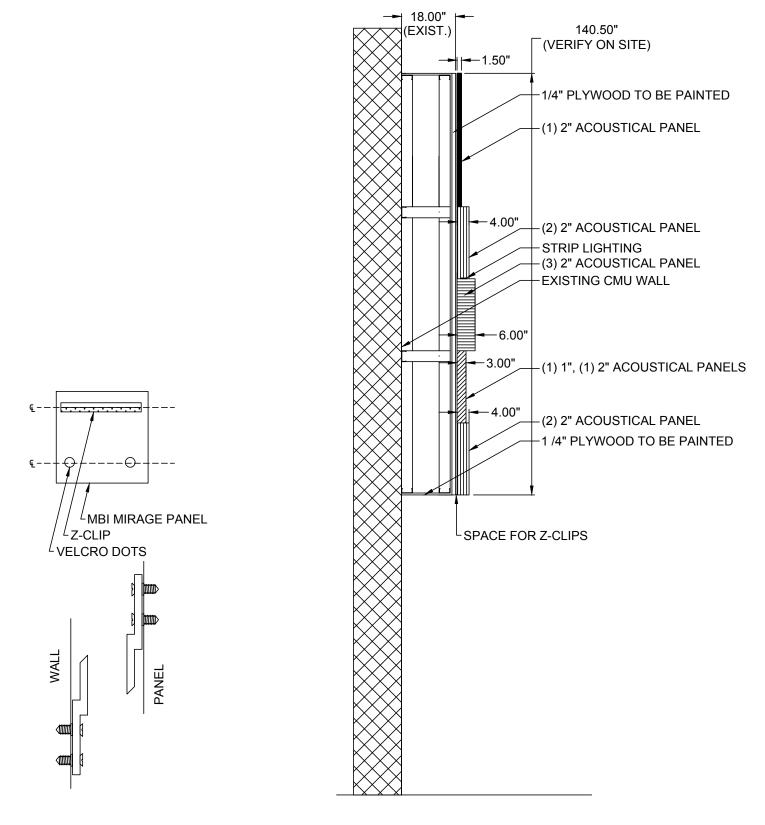
SHEET NO:

GYMNASIUM FLOOR PLAN % RCP

PROJECT NO: 1310
AUGUST 14, 2015
SCALE: AS NOTED

AX101



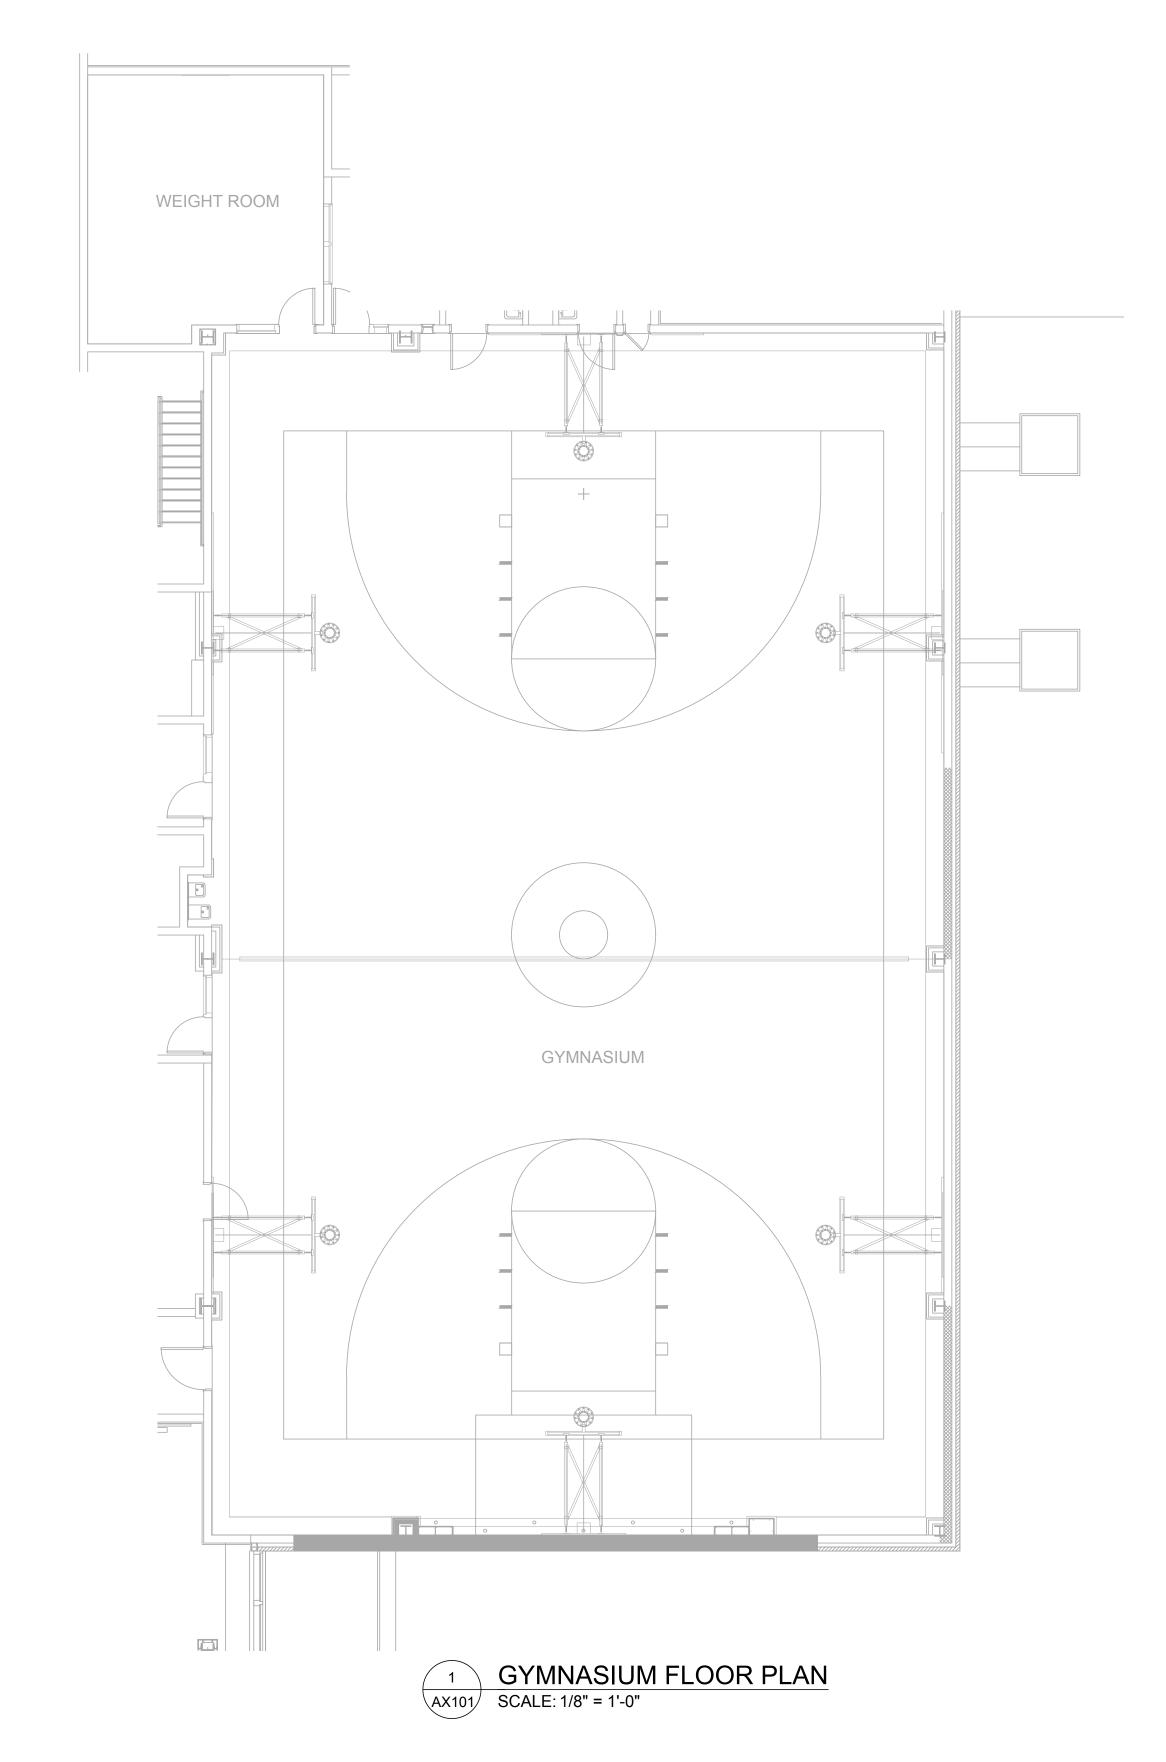

1 ACOUSTICAL WALL PANELS INSTALATION DETAIL
AX501 SCALE: NTS

GS (DEPARTMENT OF GENERAL SERVICES) 60 U STREET, NW, ASHINGTON, DC 20009 CHITECT ANCE BAILEY & ASSOCIATES 60 GEORGIA AVENUE, NW ASHINGTON, DC 20012 (301)565-2283 F: (301)565-2287 RUCTURAL ENGINEER ONSULTING STRUCTURAL ENGINEER	
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301-816-0648 F: 301-816-0649 w.mgvengineers.com ECTRICAL ENGINEER	
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40)5 Belle Air Lane Warrenton, VA 20186 540-341-4988	

DATE
07/28/15
08/14/15
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REVISION SCHEDULE	DATE
NO DESCRIPTION	

PROJECT:

DYRS GYMNASIUM **RENOVATION**

1000 MOUNT OLIVET ROAD, NE WASHINGTON, DC 20002

SHEET TITLE:

DETAILS

PROJECT NO: 1310 AUGUST 14, 2015

AS NOTED

SCALE:

SHEET NO:

AX501

DYRS GYMNASIUM RENOVATION

NE WASHINGTON D.C.

CONSTRUCTION DOCUMENTS
AUDIOVISUAL SET
AUGUST 14, 2015



POLYSONICS

Acoustics & Technology Consulting

405 Belle Air Lane Warrenton, VA 20186 540-341-4988

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DGS (DE	PARTMENT OF GENERAL SERVICES)
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LANCE B	AILEY & ASSOCIATES
7600 GEORG	IA AVENUE, NW
WASHINGTO	
1. (301)363-22	283 F: (301)565-2287
STRUCTURAL	L ENGINEER
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	TIVE BULEVARD IESDA, MD 20852-3906
	i48 F: 301-816-0649
www.mgvengi	neers.com
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	NSIN AVENUE, NW, SUITE 300
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WASHINGTOL T: (202) 495-7 CIVIL ENGINE 10 G STREET WASHINGTOL	746 F: (202) 495-7747 EER 7, NE, SUITE # 430

SUBMISSION SCHEDULE DATE
50% DESIGN DEVELOPMENT 07/28/15
CONSTRUCTION DOCUMENTS 08/14/15

REVISION SCHEDULE DATE

NO DESCRIPTION

PROJECT:

405 BELLE AIR LANE WARRENTON, VA 20186

DYRS GYMNASIUM RENOVATION

1000 MOUNT OLIVET ROAD, NE WASHINGTON, DC 20002

SHEET TITLE:

COVER

PROJECT NO: 1310 AUGUST 14, 2015

SCALE: AS NOTED

SHEET NO:

TA000

SHEET INDEX

SHEET NUMBER	SHEET NAME
TA000	COVER
TA001	NOTES
TA002	NOTES
TA101	GYMNASIUM FLOOR PLAN & RCP
TA501	DETAILS

LINE DIAGRAM LEGENDS

TC


TGB

TELECOMMUNICATIONS CONTRACTOR

UNLESS OTHERWISE NOTED

TELECOMMUNICATIONS GROUNDING BUS BAR

TELECOMMUNICATIONS MAIN GROUNDING BUS BAR

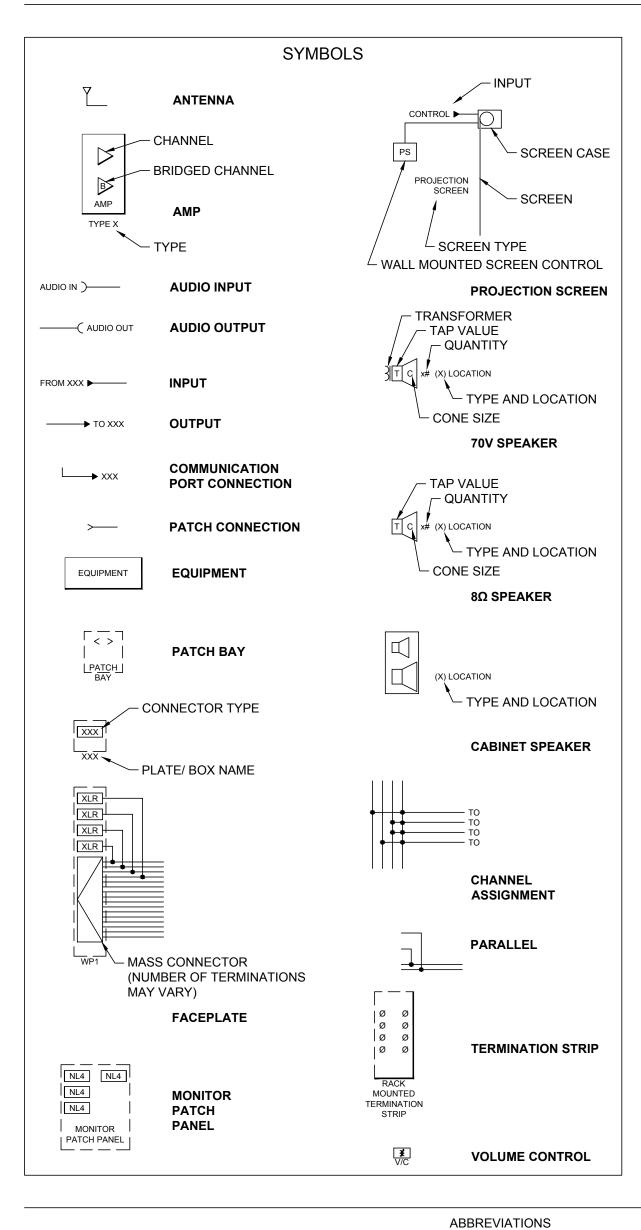

ABOVE ACCESSIBLE CEILING

AUDIOVISUAL CONTRACTOR

AUDIOVISUAL CABLE TRAY

ELECTRICAL CONTRACTOR

GENERAL CONTRACTOR

INTERMEDIATE DATA FRAME

MAIN EQUIPMENT ROOM

REFLECTED CEILING PLAN

STUB TO CABLE TRAY

STAGE EQUIPMENT CONTRACTOR

PROJECT STANDARD RECEPTACLE HEIGHT PROJECT STANDARD SWITCH HEIGHT

JUNCTION BOX "X"
MAIN DATA FRAME

AUDIO-VIDEO RACK

CABLE TELEVISION

CABLE TRAY

GANG

MOUNTED

STANDARD

PAN/ TILT/ ZOOM

ABOVE FINISHED FLOOR

AFF

CATV

CT

GC

MDF

MER

PTZ

SEC

STC

STD

	CONNECTION TYPES
SYMBOL	CONNECTOR
1/4	TRS PHONE
1/8	3.5MM TRS MINI PHONE
BNC	BAYONET NEILL-CONCELMAN
DIN	DEUTSCHES INSTITUT FÜR NORMUNG
DP	DISPLAY PORT
DVID	DVI-DIGITAL DUAL LINK
DVII	DVI-INTEGRATED DUAL LINK
F	COAX F
HD15	VGA 15-PIN
HD9	RS232 9-PIN
HDMI	HDMI
LC	FIBER OPTIC LC
LGT	LIGHTNING
MASS	MASS CONNECTOR
MXLR	MINI XLR MALE
NL4	NEUTRIK NL4
NL8	NEUTRIK NL8
PHX	PHOENIX
RCA	PHONO
RJ11	PHONE CONNECTOR
RJ45	CATEGORY CABLE
SC	FIBER OPTIC SC
SJ45	SHIELDED RJ45
ST	FIBER OPTIC ST
SVID	S-VIDEO MINI DIN
USBA	UNIVERSAL SERIAL BUS - TYPE A
USBB	UNIVERSAL SERIAL BUS - TYPE B
USBM	UNIVERSAL SERIAL BUS - TYPE B MINI
XLR	XLR FEMALE
XLR4	XLR 4-PIN FEMALE
XLR5	XLR 5-PIN FEMALE
XLRM	XLR MALE

SUBMISSION SCHEDULE	DA
50% DESIGN DEVELOPMENT	07/
CONSTRUCTION DOCUMENTS	08/
REVISION SCHEDULE	DA

DGS (DEPARTMENT OF GENERAL SERVICES)

1250 U STREET, NW, WASHINGTON, DC 20009

LANCE BAILEY & ASSOCIATES

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GLOBAL ENGINEERING SOLUTION

5225 WISCONSIN AVENUE, NW, SUITE 300

7600 GEORGIA AVENUE, NW

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6239 EXECUTIVE BULEVARD NORTH BETHESDA, MD 20852-3906

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10 G STREET, NE, SUITE # 430

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Warnburg A. 386

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PROJECT:

DYRS GYMNASIUM **RENOVATION**

1000 MOUNT OLIVET ROAD, NE WASHINGTON, DC 20002

SHEET TITLE:

NOTES

SHEET NO:

PROJECT NO: 1310
AUGUST 14, 2015
SCALE: AS NOTED

TA001

DEVICE SCHEDULE

DEVICE NAME	DESCRIPTION	POWER	PHONE/DATA	BOX SIZE	<u>HEIGHT</u>	Comments
S	CEILING MOUNTED LOUDSPEAKER	NO	NO	NA	CEILING	
WP1	WALL MOUNTED BOX AND PLATE FOR AV CONECTIONS IN GYM	YES (QUAD)	NA	2-GANG	RECEPTACLE HEIGHT	

GENERAL PROJECT NOTES

- REFER TO ARCHITECTURAL DRAWINGS FOR EXACT LOCATIONS OF ALL AV DEVICES.
- DEVICE ICONS ARE NOT SCALED. DEVICE WILL BE CENTERED WHERE THE SYMBOL IS LOCATED AT EACH FLOOR, CEILING AND WALL LOCATION.
 ALL AV PLATES PROVIDED AND INSTALLED BY AV CONTRACTOR UNLESS OTHERWISE NOTED.

AV CONDUIT AND BACK BOX REQUIREMENTS


- 1. AV DRAWINGS DO NOT INCLUDE CONDUIT FOR ELECTRICAL OR TELECOM REQUIREMENTS.
- 2. CONDUIT ARROWS ON DRAWINGS DO NOT SHOW DIRECTION OR PATH OF CONDUIT.
- 3. ALL JUNCTION BOXES/BACK BOXES AND CONDUIT SUPPLIED AND INSTALLED BY ELECTRICAL CONTRACTOR UNLESS OTHERWISE NOTED.
- 1. INSTALL ALL CONDUIT WITH PULL STRING. ANY CONDUIT NOT USED DURING PROJECT SHALL HAVE PULL STRING REMAIN IN PLACE FOR FUTURE USE.
- 5. ALL FIXTURE BOXES ASSUME DOUBLE DEEP UNLESS OTHERWISE NOTED.
- 6. ALL AV CONDUIT IS 3/4" UNLESS OTHERWISE NOTED.7. AV CONTRACTOR TO PROVIDE BLANK COVER PLATES FOR ALL WALL/FLOOR BOXES THAT ARE NOT UTILIZED.
- 8. INSTALL RACEWAY AND OUTLET BOX SYSTEM CONTINUOUS FROM OUTLET TO JUNCTION BOX AND TO EQUIPMENT LOCATION WITH NO MORE THAN FOUR (4) QUARTER BENDS
- (360 DEGREES TOTAL).


 9. PULL BOXES SHALL BE PROVIDED EVERY 100 FEET OF CONTINUOUS CONDUIT RUN.
- 10. PULL BOXES SHALL NOT BE USED IN-LIEU OF CONDUIT BENDS. PULL BOXES ARE FOR STRAIGHT THROUGH CABLE ROUTING ONLY.
- 11. INSTALL RACEWAY FROM OUTLET BOXES TO CABLE LADDER IN CORRIDOR AS INDICATED WHERE REQUIRED.12. INSTALL RACEWAY FROM OUTLET BOXES TO ACCESSIBLE CEILING SPACES WHERE REQUIRED.
- 12. INSTALL RACEWAY FROM OUTLET BOXES TO ACCESSIBLE CEILING SPACES WHERE REQUIRED.


 13. ALL J-HOOKS REQUIRED TO SUPPORT AV CABLE TO BE INSTALLED BY GC.
- 13. ALL J-HOOKS REQUIRED TO SUPPORT AV CABLE TO BE INSTALLED BY GC.


 14. BUSH AND REAM ALL CONDUIT ENDS. TERMINATE WITH INSULATED BUSHING IF CONDUIT END IS EXPOSED.
- 15. CLAMP CONDUIT TO TRAY/LADDER FOR PROPER SUPPORT WHERE REQUIRED.
- 16. ALL DEDICATED AV CABLE TRAY FOR AV RACKS SHALL BE PROVIDED AND INSTALLED BY AV CONTRACTOR UNLESS OTHERWISE NOTED.

 17. WHERE CABLE TRAY/LADDER IS NOT UTILIZED, MAKE CONTINUOUS RUNS FROM BOX TO BOX WITH ISOLATION FROM BUILDING SYSTEMS AS REQUIRED.
- 18. PROVIDE SLEEVES AND APPROPRIATE WALL PENETRATIONS AS NEEDED FOR CABLE PATHWAYS FROM OUTLET AND JUNCTION BOX LOCATIONS TO CORRIDOR CABLE TRAY AND/OR J-HOOKS. MINIMUM SLEEVE SIZE FOR TYPICAL SPACES SHALL BE 2" EMT. FIRESTOP PER CODE AND FIREWALL RATINGS.

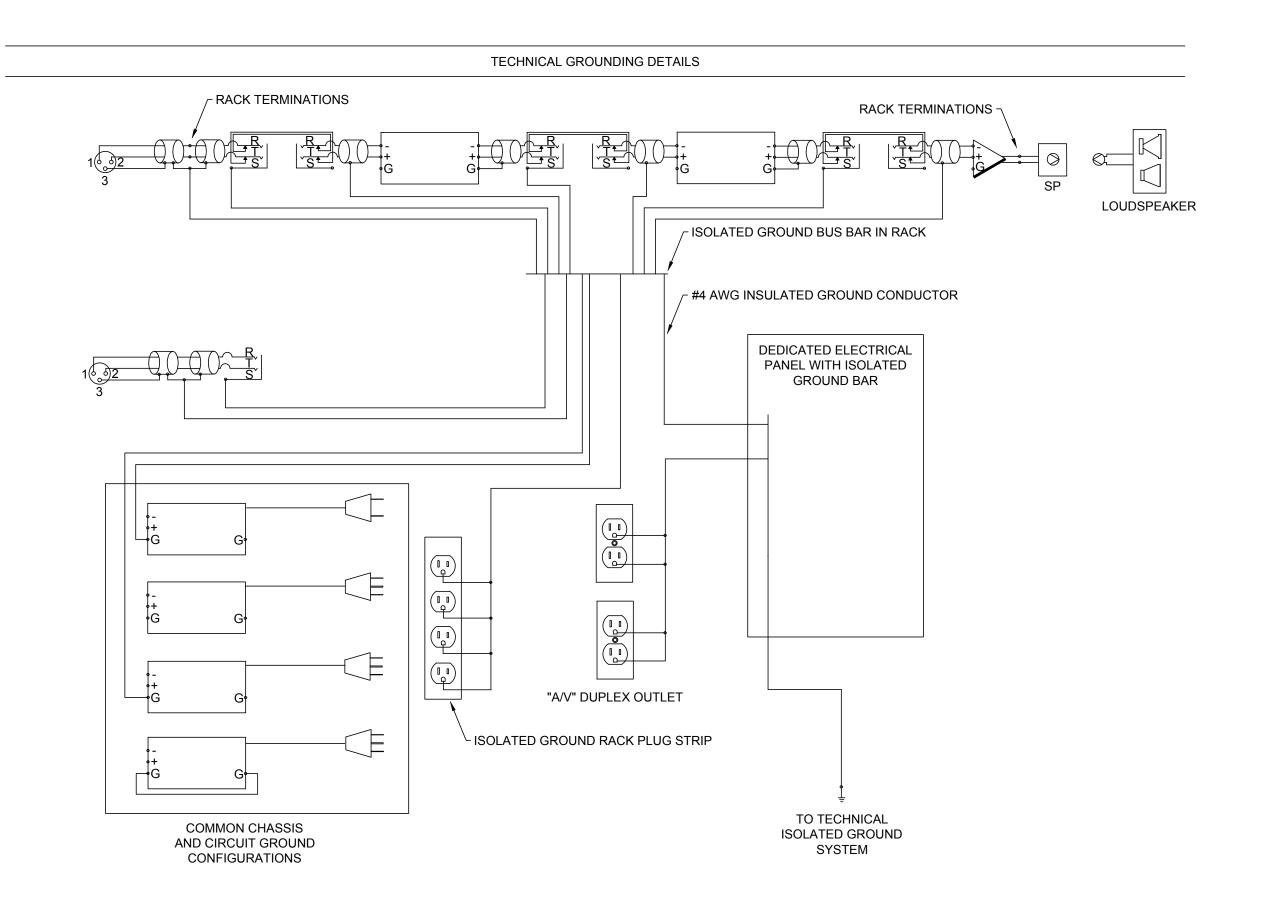

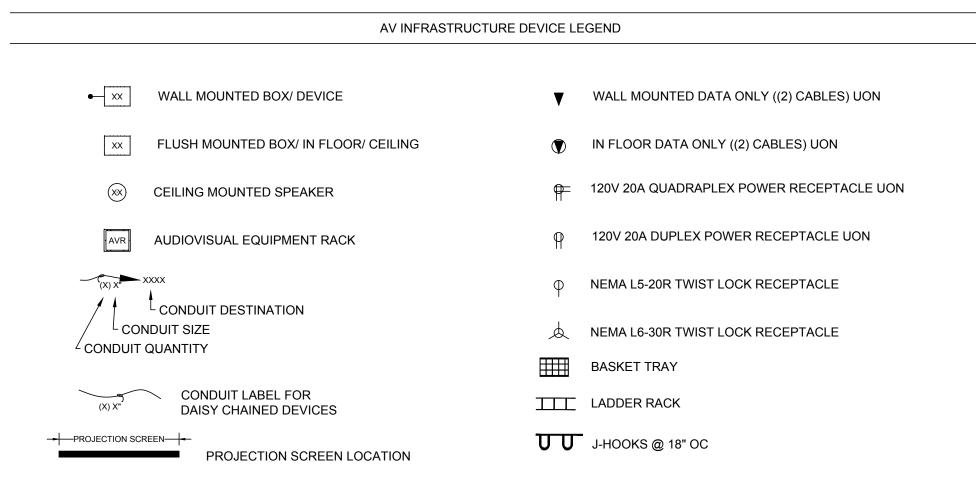

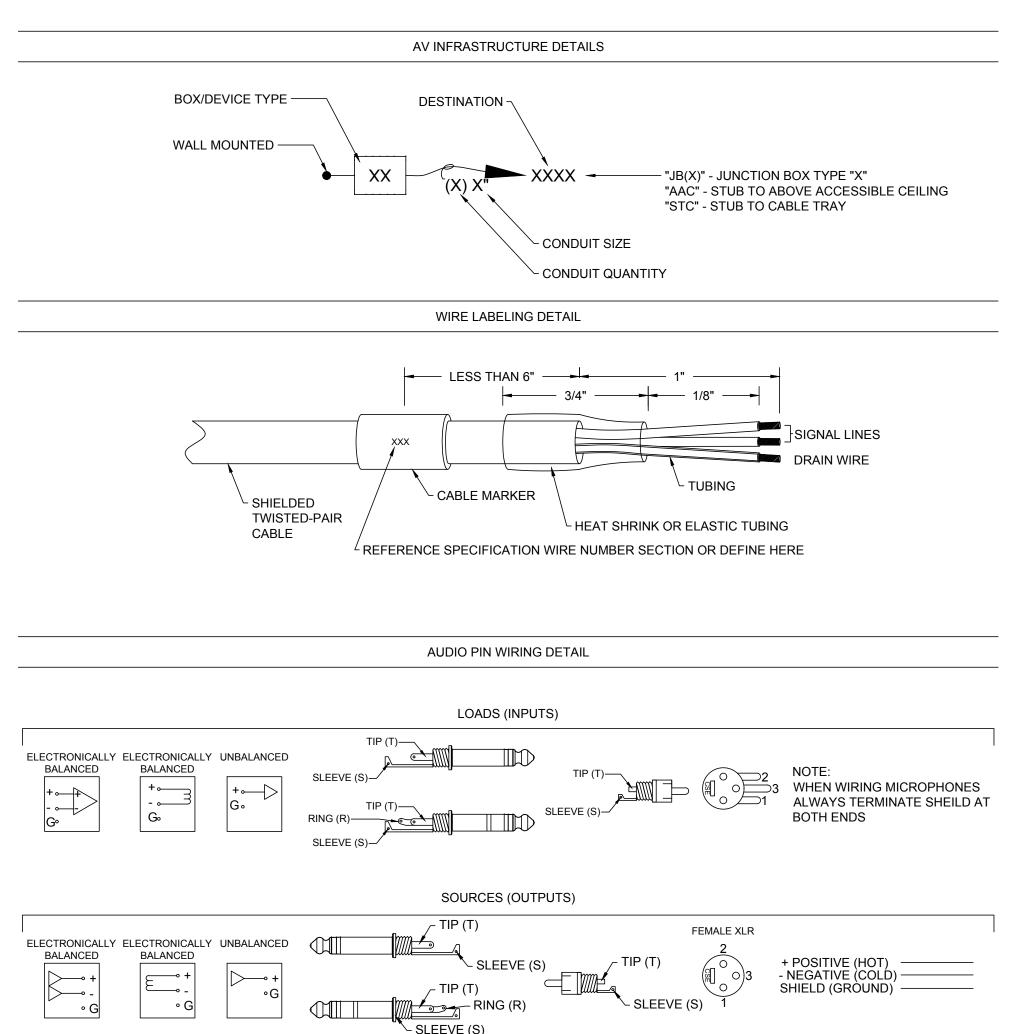

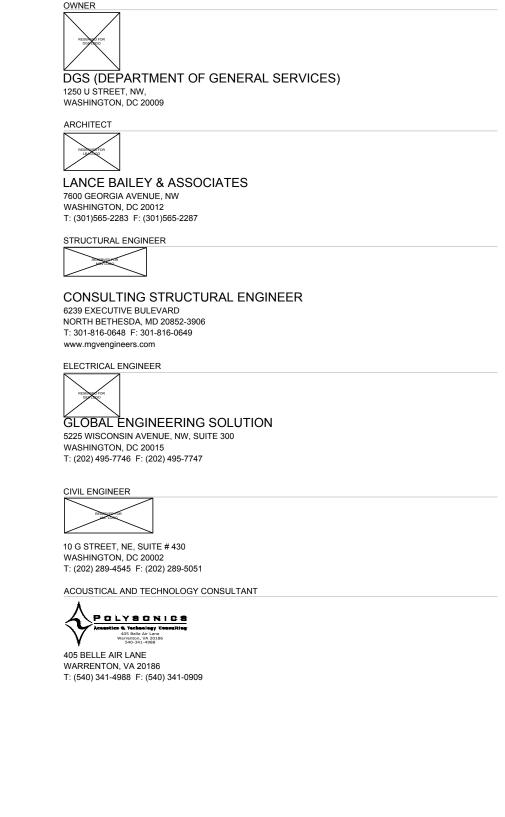

50% DESIGN DEVELOPMENT

CONSTRUCTION DOCUMENTS

08/14/15

REVISION SCHEDULE

NO DESCRIPTION

PROJECT:

DYRS GYMNASIUM **RENOVATION**

1000 MOUNT OLIVET ROAD, NE WASHINGTON, DC 20002

SUBMISSION SCHEDULE

SHEET TITLE:


PROJECT NO: 1310


AUGUST 14, 2015


SCALE: AS NOTED

SHEET NO:

DATE

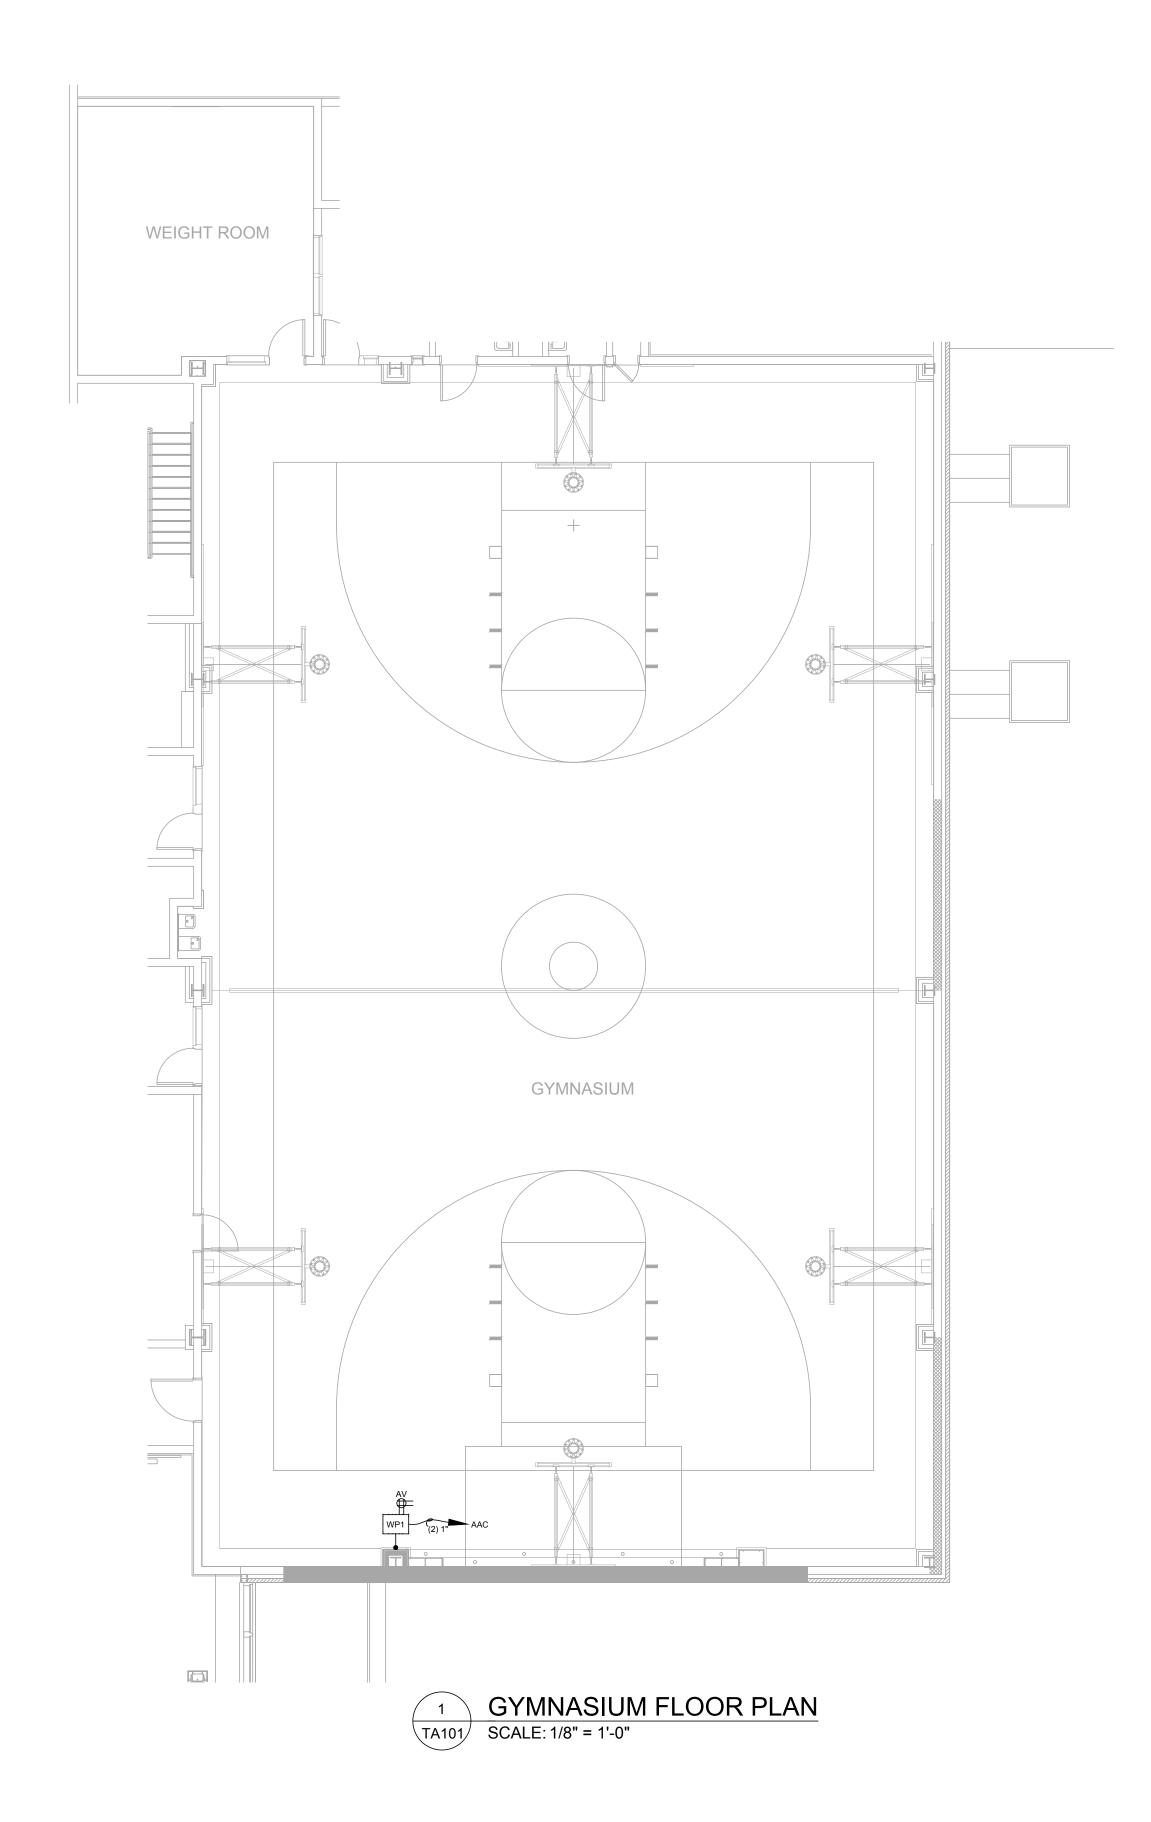

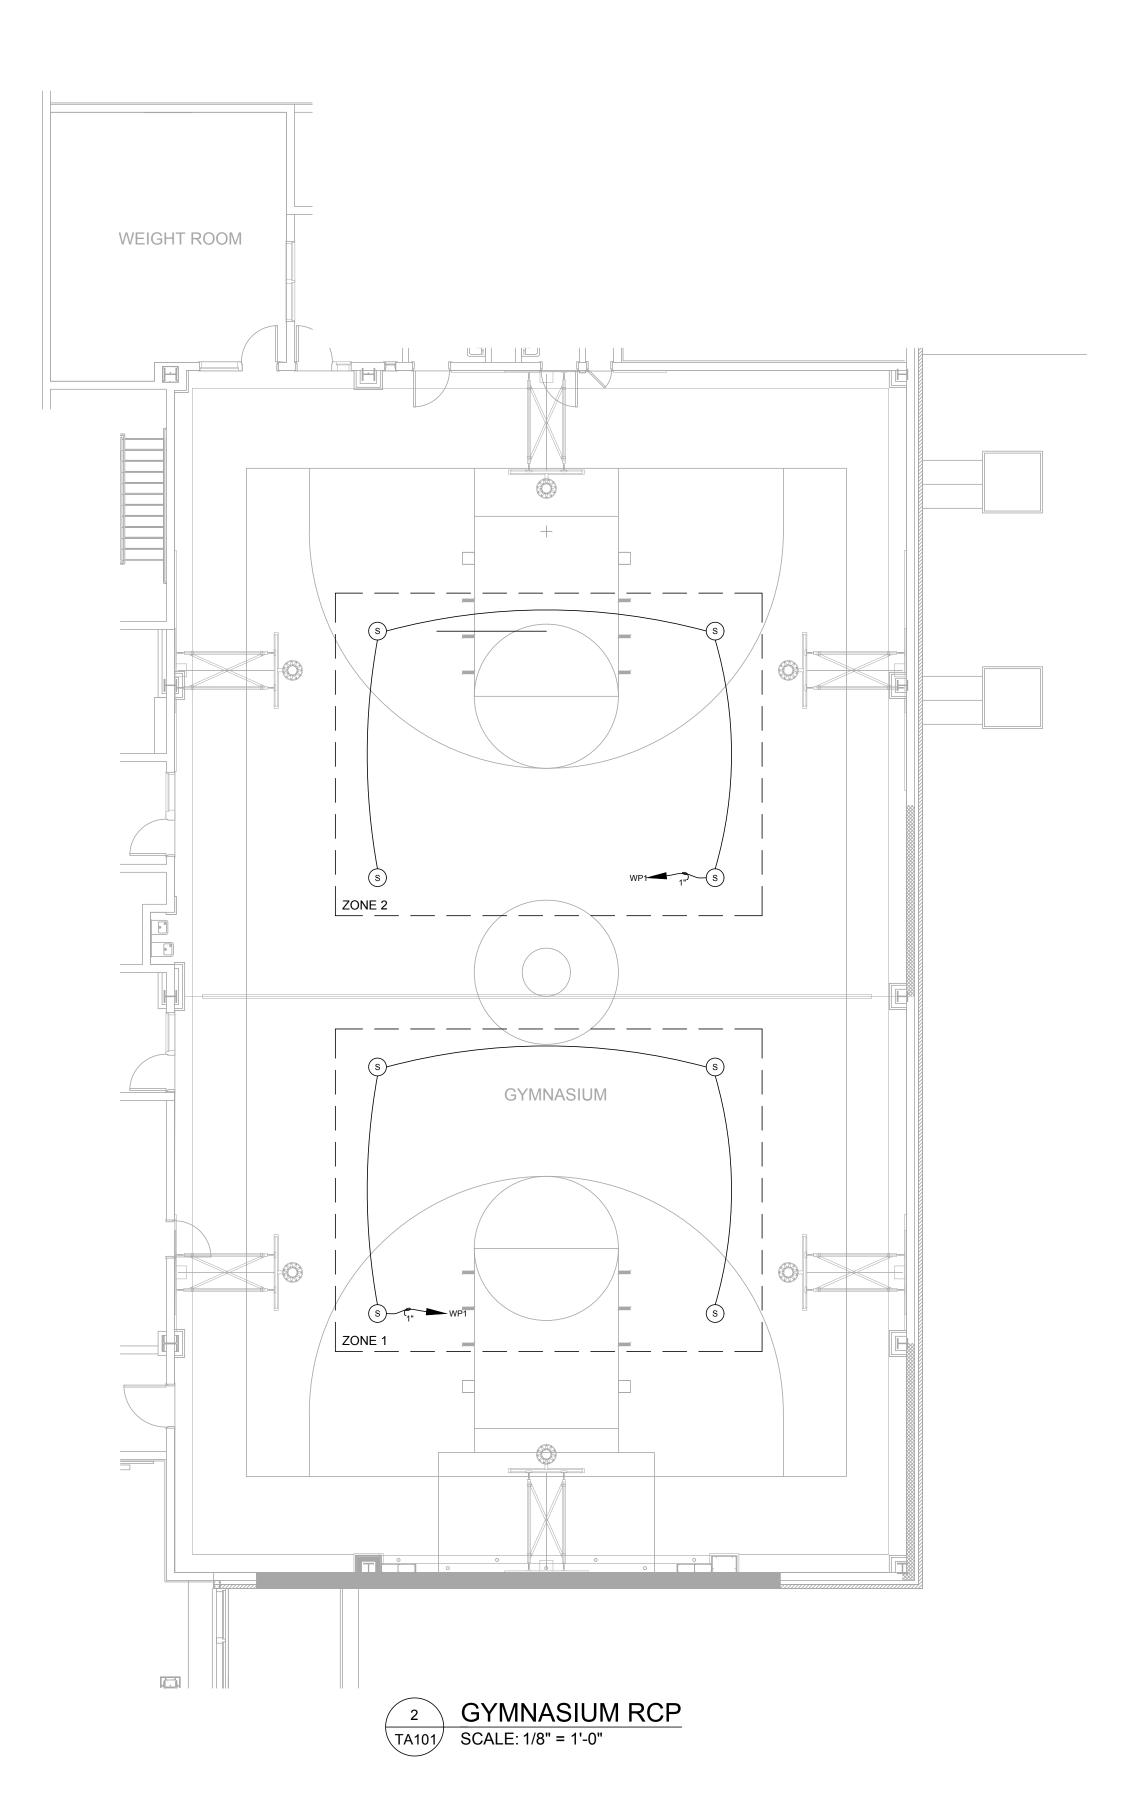

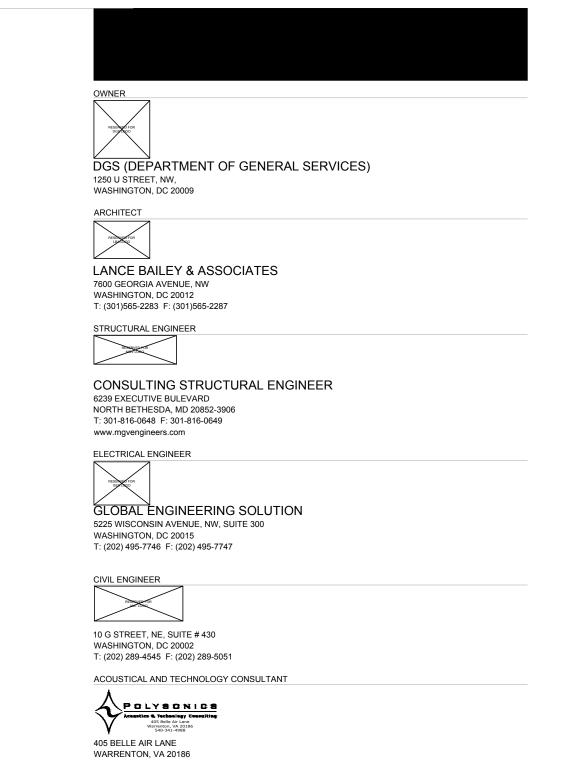

T: (540) 341-4988 F: (540) 341-0909

07/28/15
08/14/15

REVISION SCHEDULE DATE

NO DESCRIPTION

PROJECT:

DYRS GYMNASIUM **RENOVATION**


1000 MOUNT OLIVET ROAD, NE WASHINGTON, DC 20002

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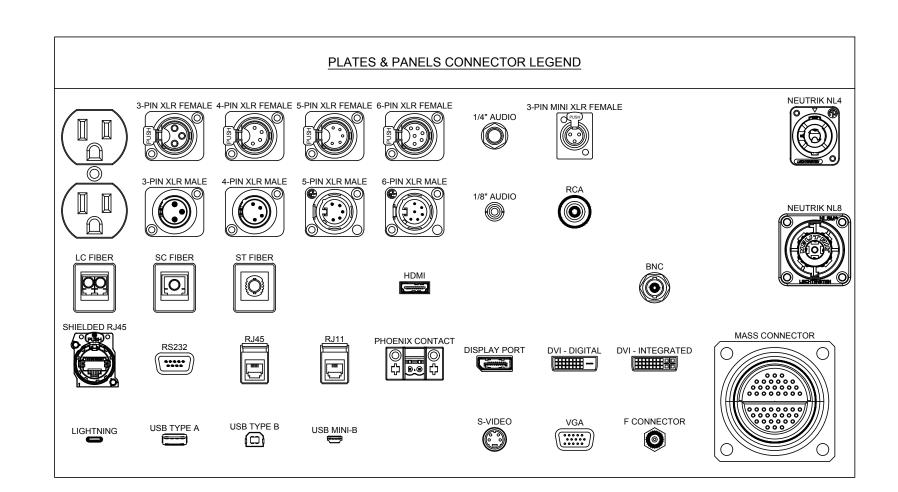
GYMNASIUM FLOOR PLAN % RCP


PROJECT NO: 1310
AUGUST 14, 2015
SCALE: AS NOTED
SHEET NO:

TA101

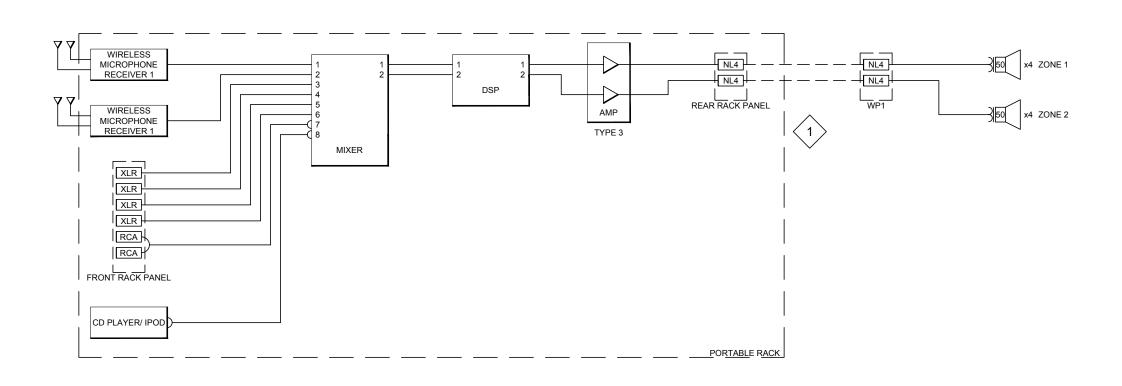


1 GYMNASIUM AUDIO LINE DIAGRAM TA501 SCALE: NTS



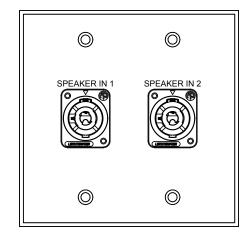

SPEAKER INPUT WALL PLATE
QUANTITY: 1
SIZE: DOUBLE GANG
FINISH: BLACK W/ WHITE LETTERING
NOTE: -

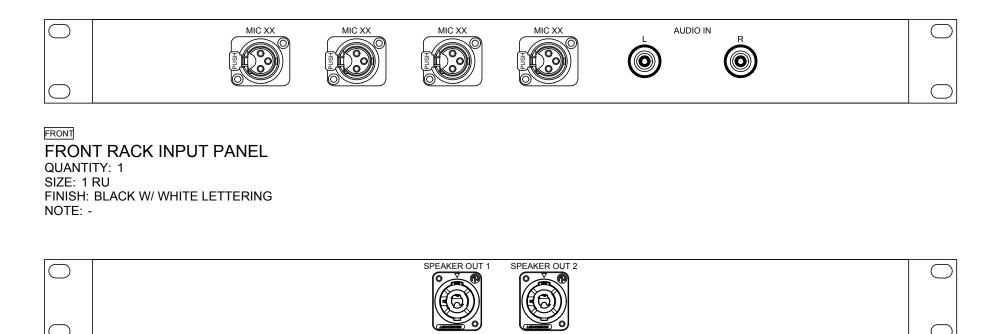


REAR
REAR RACK INPUT PANEL
QUANTITY: 1
SIZE: 1 RU
FINISH: BLACK W/ WHITE LETTERING
NOTE: -

3 PLATES AND PANEL DETAILS
TA501 SCALE: NTS

KEY NOTE:


1. CONNECTIONS BETWEEN RACK AND WALL PLATE IS PRESENT ONLY WHEN IN USE.

2. PORTABLE RACK IS GATOR G-SHOCK-16L.

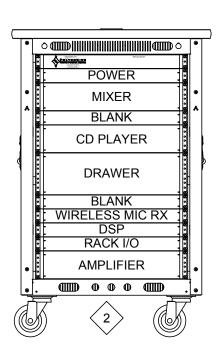


GYMNASIUM PORTABLE RACK
TOTAL AMPS: 3
TOTAL WATTS: 228
TOTAL BTU: 776
CIRCUITS: (1) 20A, 120V

GYMNASIUM PORTABLE RACK ELEVATION
SCALE: NTS

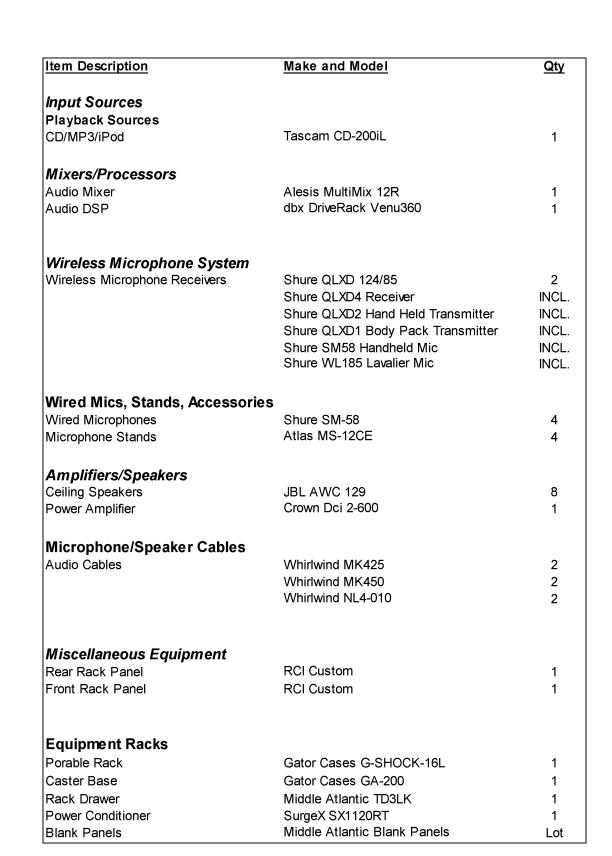



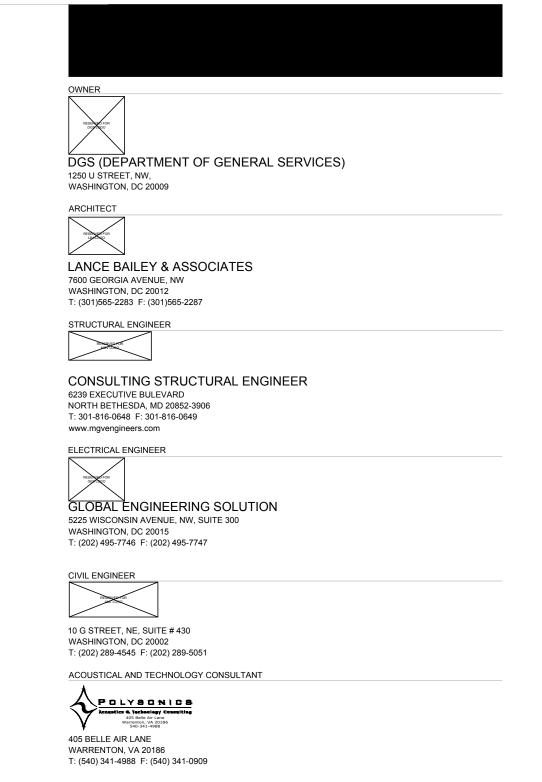

50% DESIGN DEVELOPMENT	07/28/15
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PROJECT:	
DYRS GYMNASIUM	
RENOVATION	
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AS NOTED

SUBMISSION SCHEDULE

SCALE:

SHEET NO:

TA501

DATE