ELECTRICAL LEGEND

GENERAL NOTES

- THE WORK TO BE DONE SHALL INCLUDE THE FURNISHING OF ALL LABOR, MATERIALS, APPLIANCES, EQUIPMENT, TOOLS, TRANSPORTATION, SUPERINTENDENTS AND SERVICES REQUIRED TO CONSTRUCT, INSTALL AND TO MODIFY THE ELECTRICAL SYSTEMS AS HEREIN SPECIFIED AND SHOWN ON THESE DRAWINGS FOR A COMPLETE OPERATIONAL SYSTEM. COORDINATE WORK TO BE PERFORMED OR INSTALLED BY OTHERS AFFECTING THE ELECTRICAL WORK AND PROVIDE AND INSTALL ALL NECESSARY ANCHORS, SLEEVES, HANGERS, ETC. FOR ATTACHING OR CONNECTING ELECTRICAL WORK TO RELATED WORK OF OTHER TRADES.
- 2. ALL ELECTRICAL WORK SHALL BE PERFORMED IN STRICT ACCORDANCE WITH THE LATEST ADOPTED NATIONAL ELECTRICAL CODE AND ALL OTHER LOCAL CODES AND AUTHORITIES HAVING JURISDICTION.
- 3. THE DRAWINGS, WHICH CONSTITUTE A PART OF THIS CONTRACT, INDICATE THE GENERAL ARRANGEMENT OF CIRCUITS AND LOCATIONS OF OUTLETS, SWITCHES, PANELBOARDS, CONDUIT AND OTHER WORK. ALL ITEMS NOT SPECIFICALLY MENTIONED HEREIN, WHICH ARE ACCESSORY TO MAKE A COMPLETE WORKING INSTALLATION, SHALL BE INCLUDED AT NO EXTRA COST.
- 4. IT SHALL BE THE RESPONSIBILITY OF THIS CONTRACTOR TO EXAMINE AND TO COORDINATE WITH THE ARCHITECTURAL, STRUCTURAL, MECHANICAL, PLUMBING AND FIRE PROTECTION DRAWINGS AND THE DRAWINGS OF ALL OTHER TRADES IN ORDER TO BECOME FAMILIAR WITH ALL ASPECTS OF THE DESIGN AFFECTING THE ELECTRICAL WORK.
- 5. CONTRACTOR SHALL COORDINATE MOUNTING HEIGHTS AND LOCATIONS OF ALL NEW ELECTRICAL DEVICES WITH ARCHITECTURAL ELEVATIONS AND DRAWINGS PRIOR TO COMMENCEMENT OF WORK. DEVICES INCLUDE BUT ARE NOT LIMITED TO RECEPTACLES, SWITCHES, FIXTURES AND TELE/DATA OUTLETS.
- 6. ALL ELECTRICAL MATERIALS SHALL BE NEW EXCEPT WHERE SPECIFICALLY NOTED AS EXISTING TO BE REUSED. ALL MATERIAL SHALL BE LISTED BY THE UNDERWRITERS LABORATORIES, INC. (UL). DEFECTIVE EQUIPMENT AND/OR EQUIPMENT DAMAGED DURING INSTALLATION AND/OR TESTING SHALL BE REPLACED OR REPAIRED IN A MANNER MEETING THE APPROVAL OF THE ARCHITECT AND THE ENGINEER. WHERE APPLICABLE, ALL EQUIPMENT SHALL BE IN ACCORDANCE WITH NEMA STANDARDS.
- 7. ALL WORK SHALL BE SUBJECT TO THE APPROVAL OF THE OWNER OR OWNER'S AUTHORIZED REPRESENTATIVE.
- 8. ALL WORK SHALL BE INSTALLED IN A NEAT AND WORKMANLIKE MANNER.
- 9. INSTALL A FIRE STOP OF ROCKWOOL FIBER OR SILICON FOAM SEALANT TO PROVIDE AN EFFECTIVE BARRIER AGAINST THE SPREAD OF FIRE AND SMOKE WHERE CONDUITS, WIREWAYS, AND OTHER ELECTRICAL RACEWAYS PASS THROUGH FIRE RATED PARTITIONS AND/OR SLABS.
- 10. ALL CERTIFICATES OF APPROVAL SHALL BE IN TRIPLICATE, DELIVERED TO THE ENGINEER, AND BECOME THE PROPERTY OF THE OWNER.
- 11. CONTRACTOR SHALL VERIFY ALL EQUIPMENT REQUIREMENTS BEFORE INSTALLING CONDUIT OR CONDUCTORS FROM POWER SOURCE TO EQUIPMENT TERMINATION.
- 12. THE CONTRACTOR SHALL X-RAY SLAB IN AREA OF PENETRATION PRIOR TO CORE DRILLING AND COORDINATE WITH EQUIPMENT IN CEILING SPACE BELOW TO CHECK FOR OBSTRUCTIONS.
- 13. CONDUCTOR INSTALLATION: HOMERUNS TO THE PANELBOARD MAY BE RUN TOGETHER IN ONE CONDUIT.
- 14. PROVIDED ALL CONNECTIONS ARE IN ACCORDANCE WITH THE NATIONAL ELECTRICAL CODE AND LOCAL ELECTRICAL CODE REQUIREMENTS, AND THE MAXIMUM UNBALANCED CURRENT IN NEUTRAL DOES NOT EXCEED THE CAPACITY OF THE WIRE, NO MORE THAN 3 SINGLE PHASE CIRCUIT SHALL BE INSTALLED IN ONE RACEWAY. ELIMINATE SPLICES WHEREVER POSSIBLE, AND WHERE NECESSARY, SPLICE IN READILY ACCESSIBLE PULL, JUNCTION OR OUTLET BOX.
- 15. MODIFICATIONS TO EXISTING PANELBOARDS: THE ELECTRICAL CONTRACTOR SHALL PROVIDE NEW CIRCUIT BREAKERS AND/OR FUSED SWITCHES AS REQUIRED. NEW EQUIPMENT SHALL MATCH EXISTING INSTALLED EQUIPMENT AND SHALL BE OF THE SAME MANUFACTURER AND TYPE AS SIMILAR EXISTING EQUIPMENT. INTERRUPT RATING OF EQUIPMENT SHALL BE THE SAME AS OF THE EXISTING EQUIPMENT.
- 16. INTERRUPTION OF ELECTRICAL POWER: THE ELECTRICAL CONTRACTOR SHALL COORDINATE ALL WORK REQUIRING INTERRUPTION OF ELECTRICAL POWER WITH THE BUILDING OWNER AND SHALL OBTAIN WRITTEN PERMISSION FROM THE BUILDING OWNER PRIOR TO SHUTTING DOWN POWER TO ANY SWITCHBOARD. THE CONTRACTOR SHALL ALSO PROVIDE NOTICE TO ALL OTHER TRADES OF ALL SCHEDULED INTERRUPTIONS OF POWER.
- 17. SITE VISIT: PRIOR TO SUBMITTING HIS BID, THE ELECTRICAL CONTRACTOR SHALL VISIT THE SITE AND FAMILIARIZE HIMSELF WITH ALL EXISTING CONDITIONS. THE ELECTRICAL CONTRACTOR SHALL NOTIFY THE ARCHITECT AND/OR ENGINEER IN ADVANCE OF ANY CONDITIONS THAT EXIST THAT WOULD PREVENT THE WORK HEREIN SPECIFIED OR SHOWN ON THE DRAWINGS FROM BEING PERFORMED. FAILURE TO SURVEY THE SITE PRIOR TO BID AND START OF CONSTRUCTION WILL NOT RELIEVE THE CONTRACTOR OF THE RESPONSIBILITY TO INSTALL DESIGN WITHIN THE CONFINES OF THE EXISTING CONDITIONS.

ELECTRICAL LEGEND

GENERAL NOTES

- 18. GUARANTEE: THE ELECTRICAL CONTRACTOR SHALL LEAVE THE ENTIRE ELECTRICAL SYSTEM INSTALLED UNDER THIS CONTRACT IN PROPER WORKING ORDER AND SHALL, WITHOUT CHARGE, REPLACE ANY WORK OR MATERIALS WHICH DEVELOP DEFECTS, EXCEPT FROM ORDINARY WEAR AND TEAR, WITHIN ONE YEAR FROM THE DATE OF FINAL ACCEPTANCE. BENEFICIAL USE SHALL NOT BE CONSTRUED AS FINAL ACCEPTANCE. THE ELECTRICAL CONTRACTOR SHALL, DURING THE ONE YEAR GUARANTEE PERIOD, BE RESPONSIBLE FOR THE PROPER REPAIR AND ADJUSTMENTS OF ALL ELECTRICAL SYSTEMS AND EQUIPMENT, APPARATUS, DEVICES, ETC, INSTALLED BY HIM, AND DO ALL WORK NECESSARY TO ENSURE EFFICIENT AND PROPER FUNCTIONING. PRIOR TO THE EXPIRATION OF THE GUARANTEE PERIOD, APPROXIMATELY 11 MONTHS AFTER FINAL ACCEPTANCE OF THIS PROJECT, A POST CONSTRUCTION REVIEW OF THE PROJECT WILL BE MADE.
- 19. THE CONTRACTOR SHALL FURNISH PERSONNEL TO ASSIST THE OWNER IN THIS REVIEW. ANY ADJUSTMENTS, REPAIRS OR REPLACEMENTS FOUND NECESSARY DURING REVIEW SHALL BE DONE BY THE CONTRACTOR, AT NO ADDITIONAL COST TO THE OWNER.
- 20. THE ELECTRICAL CONTRACTOR SHALL BE RESPONSIBLE FOR, AND SHALL INCUR FINANCIAL RESPONSIBILITY FOR ANY DAMAGES CAUSED BY, OR RESULTING FROM, DEFECTS IN HIS WORK.
- 21. THE ELECTRICAL CONTRACTOR SHALL MAINTAIN AT THE SITE, FOR THE OWNER, ONE COPY OF ALL DRAWINGS, ADDENDA, APPROVED SHOP DRAWINGS, REVISIONS AND OTHER MODIFICATIONS, IN GOOD ORDER AND MARKED TO RECORD ALL CHANGES MADE DURING CONSTRUCTION. THE SET OF DRAWINGS AND OTHER INFORMATION SHALL BE DELIVERED TO THE OWNER AND ONE COPY GIVEN TO THE ENGINEER UPON COMPLETION OF WORK.
- 22. ALL CONDUCTORS SHALL BE COPPER, CONFORMING TO THE LATEST REQUIREMENTS OF THE NATIONAL ELECTRICAL CODE, STRANDED FOR NO. 8 AWG AND LARGER, SOLID FOR NO. 10 AWG AND SMALLER.
- 23. ALL WIRING SHALL BE INSTALLED IN CONDUIT (EMT WITH STEEL COMPRESSION FITTINGS OR TYPE MC CABLE WHERE ALLOWED BY CODE). MINIMUM CONDUIT SIZE SHALL BE 3/4". ALL CONDUIT AND WIRING SHALL BE CONCEALED IN CEILINGS AND/OR WALLS UNLESS SPECIFICALLY NOTED OTHERWISE. CHANNEL EXISTING WALLS WHERE REQUIRED. WHERE WIRING RUNS ARE EXPOSED DUE TO THE LACK OF A NEW FINISHED CEILING, EMT SHALL BE USED. INSTALL ALL CONDUITS IN RUNS WHICH ARE PARALLEL AND PERPENDICULAR WITH BUILDING LINES.

ELECTRICAL LEGEND

POWER

NOTES: REFER TO ARCHITECTURAL DRAWINGS AND ELEVATIONS FOR EXACT LOCATION AND MOUNTING HEIGHTS.

- WP: WEATHER PROOF (NEMA 3R)
- ISOLATED GROUND.
- GFI: GROUND FAULT INTERRUPTER.
- WALL MOUNTED 20A DUPLEX RECEPTACLE. (18" AFF UON).

WALL MTD. SPECIAL RECEPTACLE. NEMA TYPE PER PLANS.

- WALL 20A QUADRUPLEX RECEPTACLE. (18" AFF UON). 0
- FLOOR MOUNTED 20A QUADRUPLEX RECEPTACLE.
- CEILING MOUNTED JUNCTION BOX.
- WALL MOUNTED JUNCTION BOX.
- DISCONNECT SWITCH NON-FUSED.
- FUSED DISCONNECT SWITCH. FUSE SIZE PER PLANS.
- COMBINATION STARTER/DISCONNECT SWITCH.
- MOTOR. REFER TO MECHANICAL PLANS FOR HORSEPOWER.

GENERAL

INDICATES REVISION. CLOUDED AREA CONTAINS THE REVISION.

- SURFACE MOUNTED PANEL.
- **ENCLOSED CIRCUIT BREAKER**

INDICATES PLAN NOTE.

BRANCH CIRCUIT HOMERUN

GROUND

INDICATES ROOM NUMBER.

#

ELECTRICAL LEGEND

ABBREVIATIONS

A, AMP AMPERES G, GND GROUND ABOVE GC GENERAL CONTRACTOR AC ALTERNATE CURRENT GROUND FAULT INRERRUPTER ABOVE FINISHED FLOOR IG ISOLATED GROUND ARCH ARCHITECTURAL, ARCHITECT INCAND INCANDESCENT

- BELOW KAIC KILOAMP INTERRUPTING CURRENT BREAKER KVA KILOVOLT AMPERES CONDUIT KILOWATTS
- CEILING LT(S) LIGHT(S) CIRCUIT M METER CENTIMETER MCS ENCLOSED MOLDED CASE SWITCH
- DIRECT CURRENT MECH MECHANICAL DISCONNECT SWITCH MOUNTING HEIGHT MAIN LUGS ONLY
- MILLIMETER DRAWING MTD MOUNTED ELECTRICAL CONTRACTOR EXHAUST FAN NEC NATIONAL ELECTRICAL CODE NO.,# NUMBER ELEC ELECTRICAL
- EMERGENCY NTS NOT TO SCALE EQUIP EQUIPMENT P POLE EXIST EXISTING PH, Ø PHASE PNL PANEL FA FIRE ALARM
- FACP FIRE ALARM CONTROL PANEL RECEP RECEPTACLE FAAP FIRE ALARM ANNUNCIATOR PANEL ROOM RM TELE TELEPHONE
- FLA FULL LOAD AMPERES TYPICAL FLUOR FLUORESCENT UON UNLESS OTHERWISE NOTED VOLTS
- WATTS
 - WITH WEATHERPROOF

LIGHTING

NOTE: REFER TO LIGHTING FIXTURE SCHEDULE FOR FIXTURE TYPES.

- A: CAPITAL LETTER ADJACENT TO FIXTURE INDICATES TYPE LOWER CASE LETTER INDICATES SWITCHING.
- INDICATES NIGHT LIGHTING UNSWITCHED FIXTURE
- SHADED CIRCLE INDICATES FIXTURE ON EMERGENCY CIRCUIT.
- WALL MOUNTED FIXTURE.
- POLE MOUNTED FIXTURE SINGLE HEAD.
- EMERGENCY BATTERY PACK LIGHT FIXTURE.
- CEILING/WALL MOUNTED EXIT SIGN SINGLE FACE. PROVIDE DIRECTIONAL ARROWS PER PLANS.
- CEILING/WALL MOUNTED EXIT SIGN DOUBLE FACE. PROVIDE
- DIRECTIONAL ARROWS PER PLANS.
- 20A. 1P. 120V TOGGLE TYPE LIGHT SWITCH.
- 20A, 1P, 120V KEY OPERATED LIGHT SWITCH.
- SLV LOW VOLTAGE LIGHT SWITCH.
- TOGGLE TYPE MOTOR STARTER WITH THERMAL OVERLOAD PROTECTION.
- WALL MOUNTED OCCUPANCY SENSOR. WATTSTOPPER DW-100 OR
- APPROVED EQUAL. DUAL RELAY WALL MOUNTED OCCUPANCY SENSOR. WATTSTOPPER
- DW-200 OR APPROVED EQUAL.
- CEILING MOUNTED OCCUPANCY SENSOR. WATTSTOPPER DT-355 OR APPROVED EQUAL.
- CEILING MOUNTED DAYLIGHT SENSOR.
- HIGH BAY LINE VOLTAGE PASSIVE INFRARED OCCUPANCY SENSOR WITH PROTECTIVE CAGE. WATTSTOPPER HB340B-L3 WITH PROTECTIVE CAGE OR APPROVED EQUAL.

LIGHTING FIXTURE SCHEDULE

TYPE	SYMBOL	DESCRIPTION	MANUFACTURER AND CATALOG NUMBER	LAMP DATA			VOLTS	NOTES
				NO.	WATTS	TYPE	VOLIS	MOILS
A	0	6" LED RECESSED DOWNLIGHT	ATLANTIC LIGHTING LED6-DLM20-35K-2	-	20	LED	277	NOTE 1
В		LED STRIPS MOUNTED ABOVE ACOUSTICAL PANELS.	CALI ALS450T-XX-LED-3.5K-30D-6W-DRY-XX"	-	6W/FT	LED	277	NOTE 1,2,3

GENERAL NOTES:

- A. EQUAL LIGHTING FIXTURE MANUFACTURERS WILL BE CONSIDERED.
- B. SEE ARCHITECTURAL DRAWINGS FOR EXACT LOCATION OF FIXTURES.

SPECIFIC NOTES:

- 1. FINAL SELECTION OF LIGHT FIXTURE ARE TO BE PROVIDED BY THE ARCHITECT.THESE FIXTURES ARE SUGGESTED LIGHT FIXTURE FOR THE
- APPLICATION INTENDED. 2. FIXTURE LENGTH SHALL BE PER DRAWING. COORDINATE WITH ARCHITECT FOR EXACT SIZE.
- 3. COORDINATE WITH ARCHITECT FOR FINISH.

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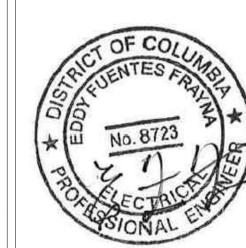
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SUBMISSION SCHEDULE	DATE
1 PERMIT SET	07-17-2015
REVISION SCHEDULE	DATE
NO DESCRIPTION	

DYRS GYMNASIUM

RENOVATION

1000 MOUNT OLIVET ROAD, NE WASHINGTON, DC 20002

SHEET TITLE:


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PROJECT:


ELECTRICAL COVER SHEET

PROJECT NO: 1310 JULY 17, 2015 SCALE:


E001

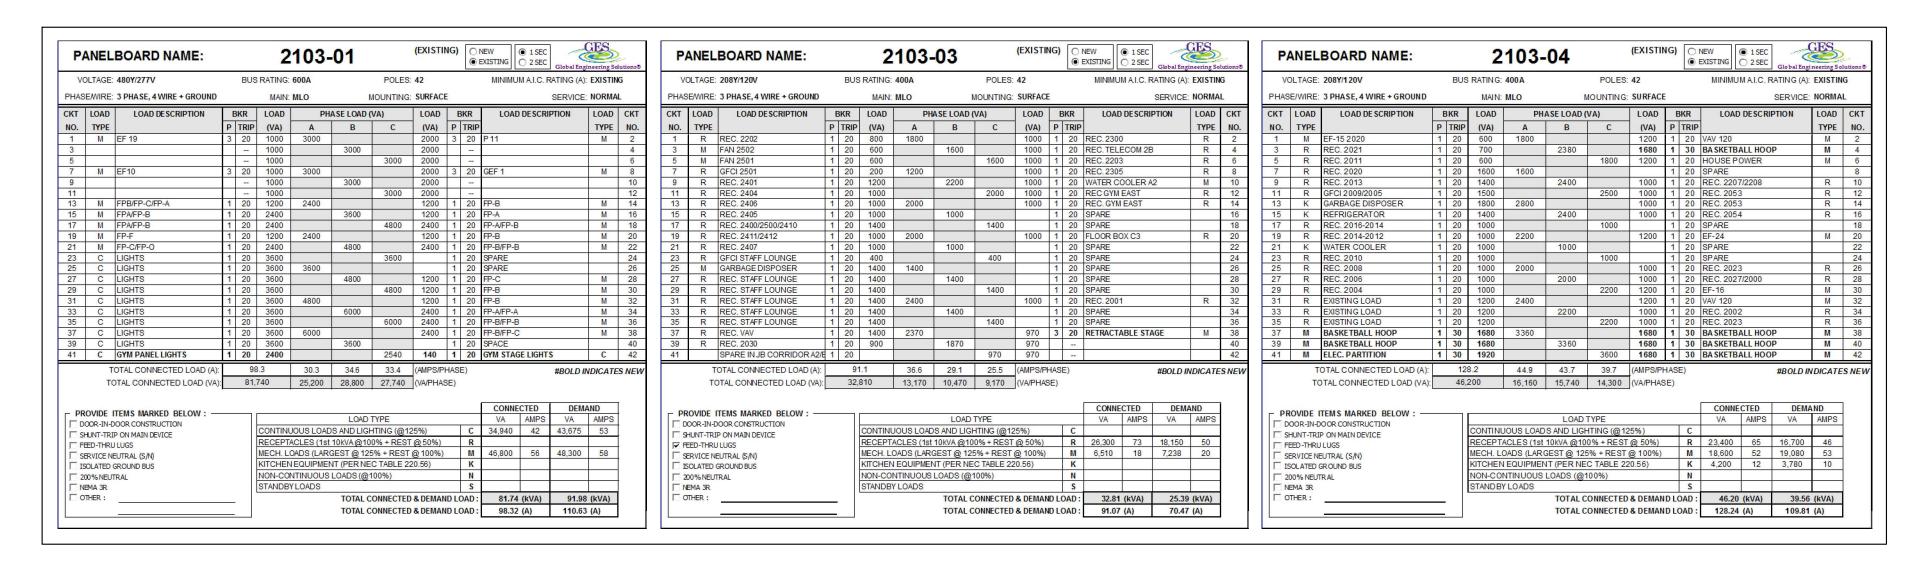

7 EXISTING PANEL SCHEDULES SCALE: NO SCALE

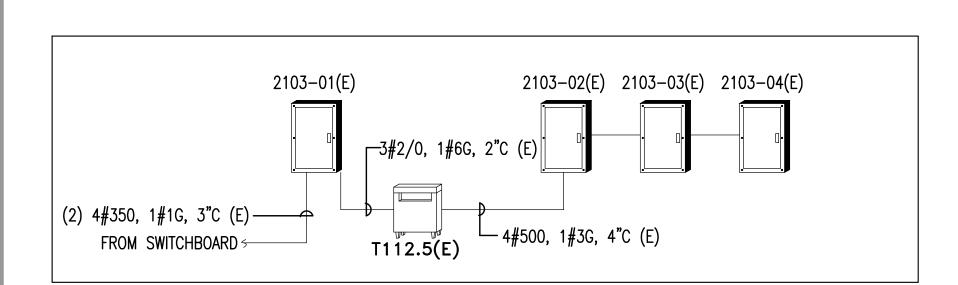



6 EXISTING PARTIAL RISER DIAGRAM

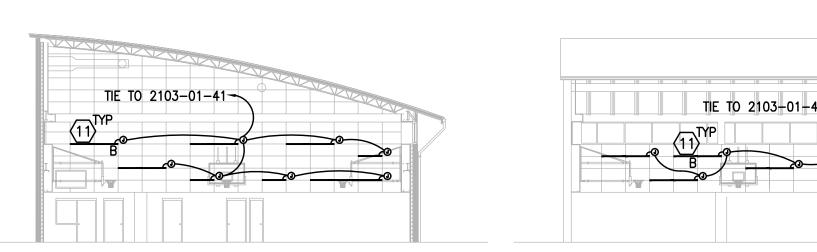

5 GYMNASIUM EAST ELEVATION SCALE: 1/16" = 1'-0"




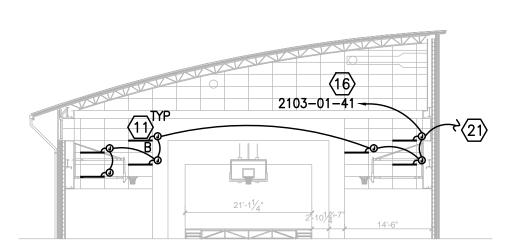

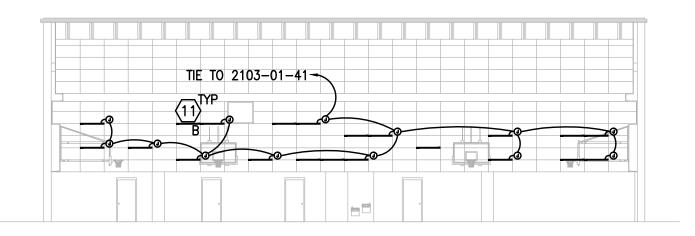





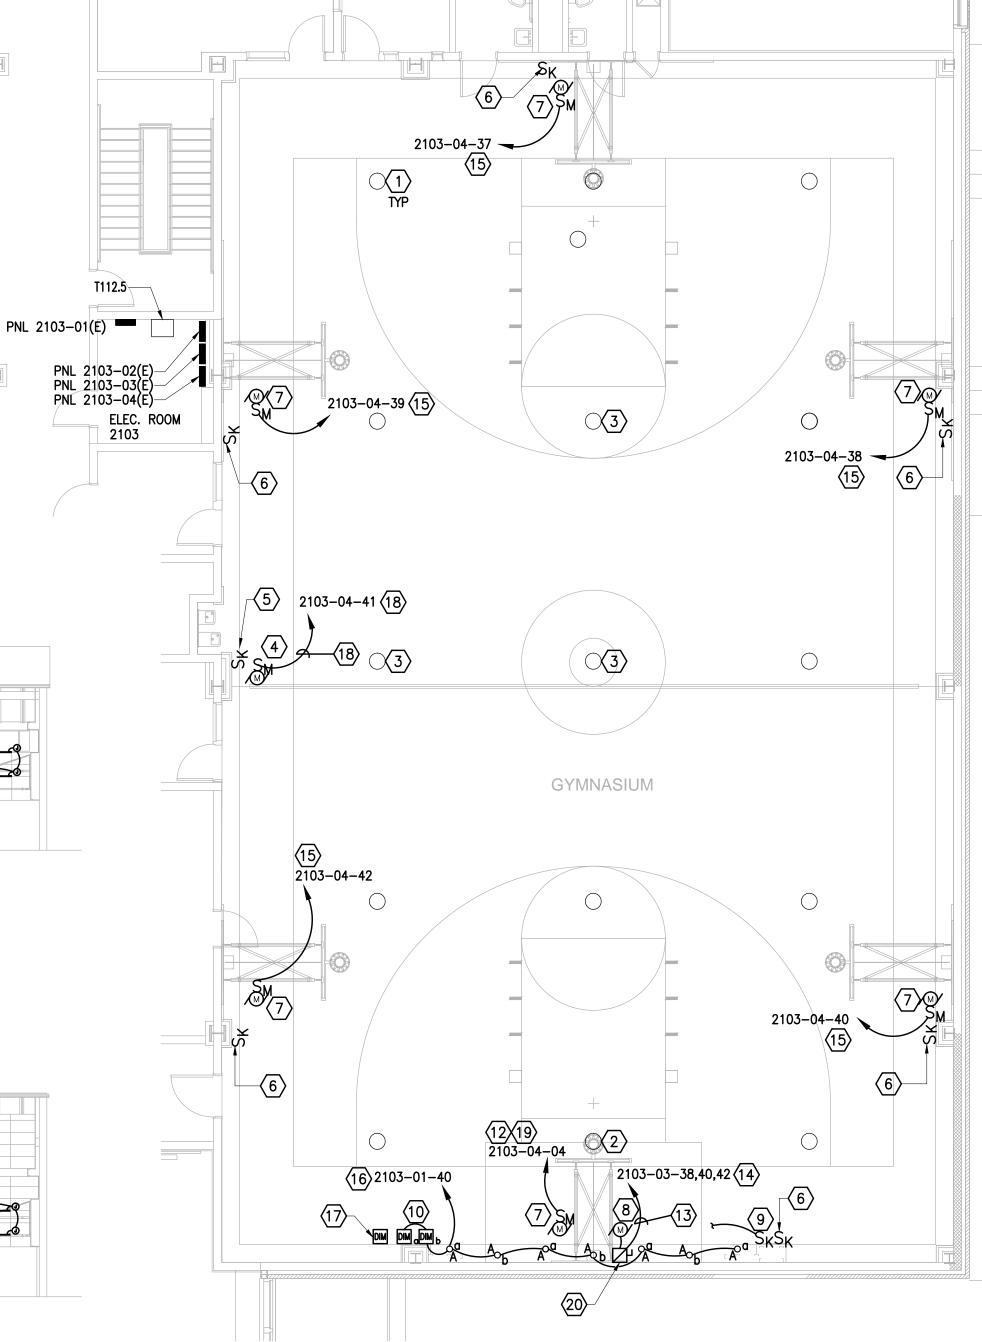

GENERAL NOTES

1. REFER TO E001 FOR GENERAL NOTES, SYMBOL LEGEND AND LIST OF ABBREVIATIONS.

SPECIFIC NOTES

- 1. EXISTING GYMNASIUM HID LIGHT FIXTURES TO REMAIN.
 CONTRACTOR SHALL CLEAN AND RE-LAMP ALL FIXTURES
 (TYPICAL OF 15) AND SHALL MAKE CERTAIN THAT ALL THE
 LIGHT FIXTURES ARE IN WORKING ORDER. SEE NOTES 2 AND
 3 BELOW FOR ADDITIONAL DETAILS.
- 2. THIS FIXTURE HAS NOISY BALLAST. CONTRACTOR SHALL REPLACE BALLAST.
- THESE FIXTURES ARE EITHER BROKEN OR NOT IN WORKING ORDER. CONTRACTOR SHALL REPLACE TO MATCH EXISTING.
- 4. ROLL-UP DIVIDER WINCH MOTOR CIRCUIT. PROVIDE MOTOR RATED TOGGLE SWITCH AS SHOWN. COORDINATE FINAL LOCATION WITH ARCHITECTURAL DRAWINGS. CONNECT TO KEY-LOCK SWITCH. SEE NOTE 5 BELOW.
- 5. KEY-LOCK, THREE POSITION MOMENTARY CONTACT SWITCH FOR CONTROL OF ROLL-UP DIVIDER. COORDINATE FINAL LOCATION WITH ARCHITECT PRIOR TO ROUGH-IN AND INSTALLATION.
- 6. KEY SWITCH FOR CONTROL OF BASKETBALL RETRACTABLE HOOP WINCH. COORDINATE FINAL LOCATION WITH ARCHITECT PRIOR TO ROUGH—IN AND INSTALLATION. KEY SWITCH IS PROVIDED WITH WINCH MOTOR. SEE NOTE 7 BELOW.
- 7. ELECTRIC WINCH MOTOR FOR RETRACTABLE BASKETBALL HOOP (TYPICAL OF 7). PROVIDE MOTOR RATED TOGGLE SWITCH AS SHOWN. COORDINATE FINAL LOCATION WITH ARCHITECTURAL DRAWINGS. CONNECT TO KEY SWITCH. SEE NOTE 6 ABOVE. WINCH SHALL BE BY SPAULDING MODEL #LYNRUS—QR4000 OR APPROVAL EQUAL.
- 8. 208V/3PHASE, 30A DISCONNECT SWITCH WITH 20A FUSES FOR RETRACTABLE STAGE. COORDINATE FINAL LOCATION WITH ARCHITECTURAL DRAWINGS AND MANUFACTURER RECOMMENDATION. CONNECT TO KEY SWITCH. SEE NOTE 9
- 9. KEY SWITCH FOR CONTROL OF RETRACTABLE STAGE.
 COORDINATE FINAL LOCATION WITH ARCHITECT PRIOR TO
 ROUGH—IN AND INSTALLATION. KEY SWITCH IS PROVIDED WITH
- THE STAGE MOTOR. SEE NOTE 8 ABOVE.

10. PROVIDE DIMMER SWITCHES FOR THE DOWNLIGHTS "a" AND :b".

- 11. LED STRIP LIGHTING. SEE LIGHTING FIXTURE SCHEDULE ON DRAWING E001 FOR FIXTURE TYPE. FIXTURE IS LOCATED ABOVE SELECTED ACOUSTICAL PANELS AS SHOWN. FOR FINAL LOCATION, LENGTH AND QUANTITY, REFER TO LATEST ARCHITECTURAL DRAWINGS. WIRING, CIRCUITING AND CONDUIT SHALL BE CONCEALED BEHIND THE PANELS SO THAT THEY ARE VISIBLE FROM THE FLOOR. COORDINATE WITH ARCHITECTURAL DETAILS PRIOR TO INSTALLATION OF THESE LIGHTS. CONTROL VIA DIMMER SWITCH. SEE NOTE 17 BELOW.
- 12. THIS 20A/1P CIRCUIT BREAKER IS IDENTIFIED AS SPARE IN CURRENT PANEL DIRECTORY IN FIELD. CONTRACTOR SHALL VERIFY AVAILABILITY OF THIS CIRCUIT IN FIELD AND COORDINATE WITH BUILDING ENGINEER TO FIND AVAILABLE CIRCUITS IF THIS IS NOT A SPARE CIRCUIT.
- 13. PROVIDE 3#12, 1#12G IN 3/4" CONDUIT.
- 4. PROVIDE NEW 20A/30P CIRCUIT BREAKER USING EXISTING SPACE IN PANEL 2103-03 IN ELECTRICAL ROOM 2103. CIRCUIT BREAKER SHALL MATCH EXISTING.
- 15. PROVIDE NEW 20A/1P CIRCUIT BREAKER USING EXISTING SPACE IN PANEL 2103-04 IN ELECTRICAL ROOM 2103. CIRCUIT BREAKER SHALL MATCH EXISTING.
- 16. PROVIDE NEW 20A/1P CIRCUIT BREAKER USING EXISTING SPACE IN PANEL 2103-01 IN ELECTRICAL ROOM 2103. CIRCUIT BREAKER SHALL MATCH EXISTING.
- 7. DIMMER FOR ACOUSTICAL PANEL LIGHTING (SEE DETAIL 2 THRU 5). COORDINATE FINAL LOCATION WITH OWNER PRIOR TO ROUGH—IN AND INSTALLATION.
- 18. PROVIDE 2#10, 1#10G IN 3/4" CONDUIT.
- 19. REPLACE 20A/1P CIRCUIT BREAKER TO 30A/1P.
- 20. 20A FUSED DISCONNECT SWITCH. COORDINATE EXACT INSTALL LOCATION IN FIELD.

KEY PLAN

21. CONNECT TO DIMMER SWITCH. SEE NOTE 17 ABOVE.



* * *

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REVISION SCHEDULE DATE	SUBMISSION SCHEDULE	DATE
	1 PERMIT SET	07-17-2015
NO DESCRIPTION	REVISION SCHEDULE	DATE
INO DESCRIPTION	NO DESCRIPTION	
	PROJECT:	

DYRS GYMNASIUM RENOVATION

1000 MOUNT OLIVET ROAD, NE WASHINGTON, DC 20002

SHEET TITLE:

GYMNASIUM ELECTRICAL PLAN

PROJECT NO: 1310

JULY 17, 2015

SCALE:
SHEET NO:

E101

GYMNASIUM ELECTRICAL PLAN

SCALE: 1/8" = 1'-0"